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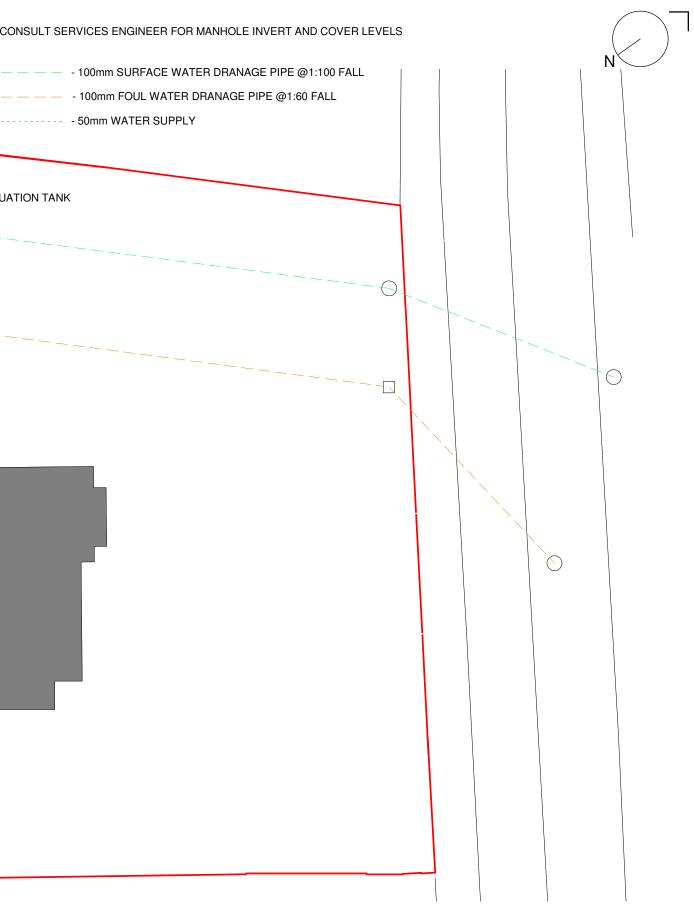





STATUS: Tender

TDS TECH4100 Assessment 3 Project 1 - Baseline Detailing Project

3.1-LD-01-XX-DR-A-T001




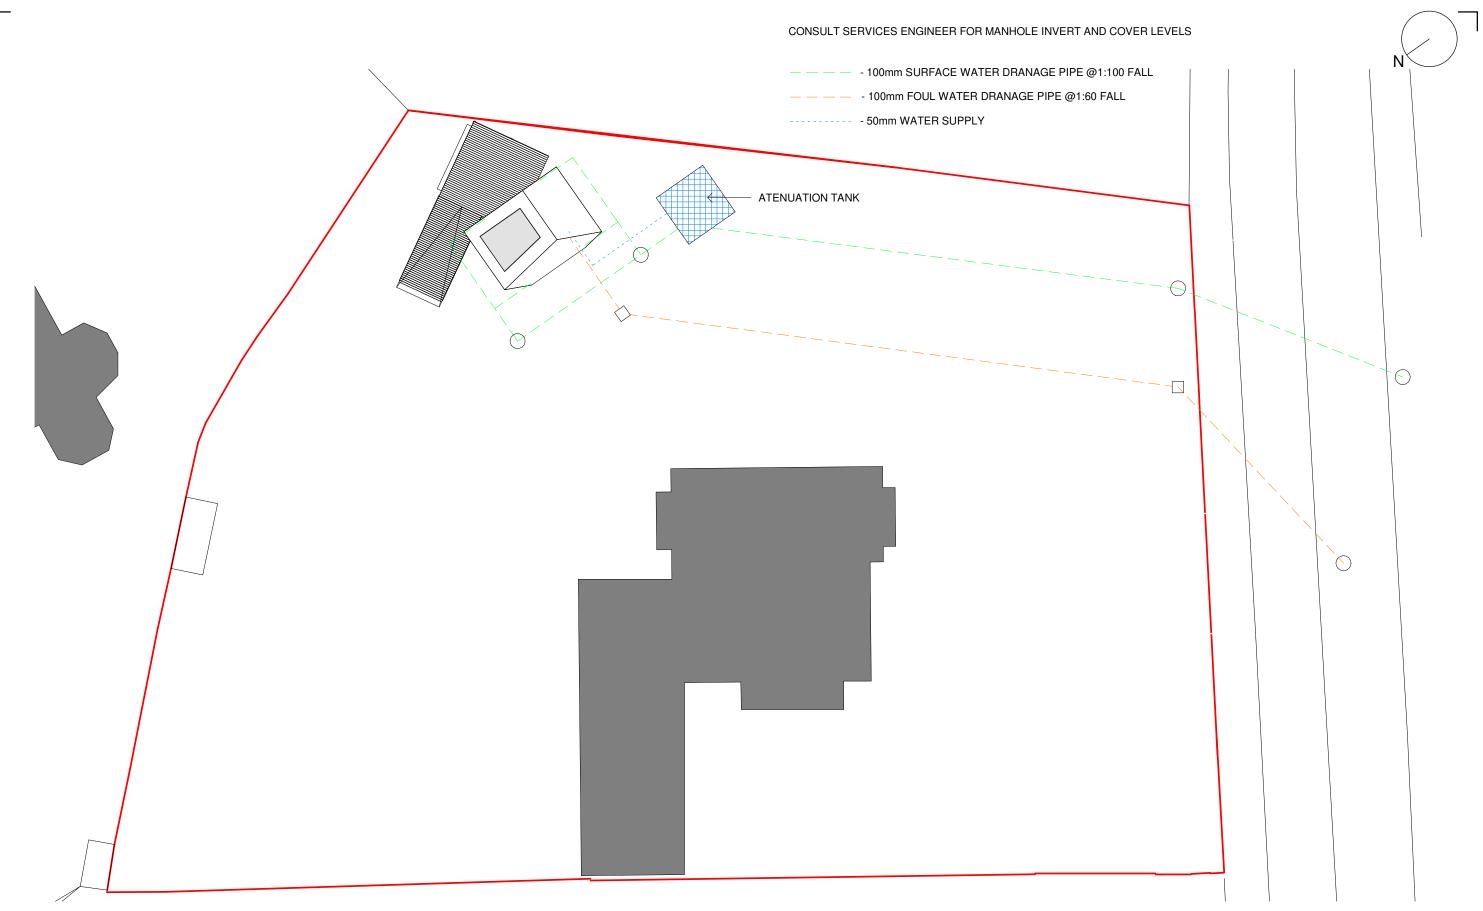


Site Drainage Plan

1:200



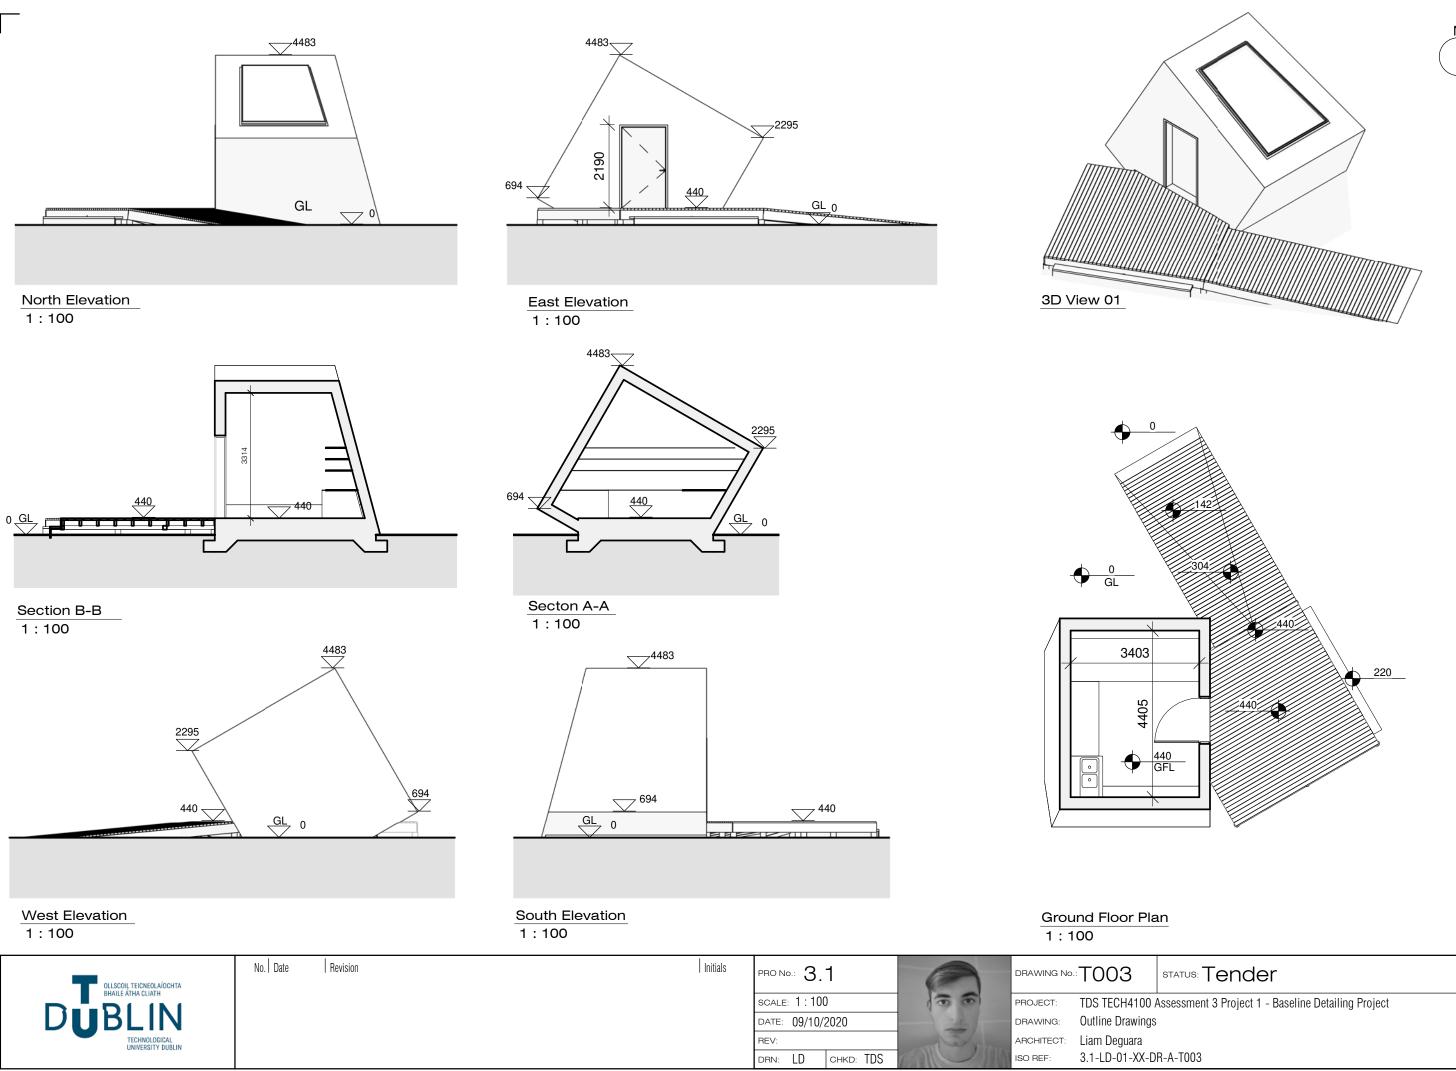

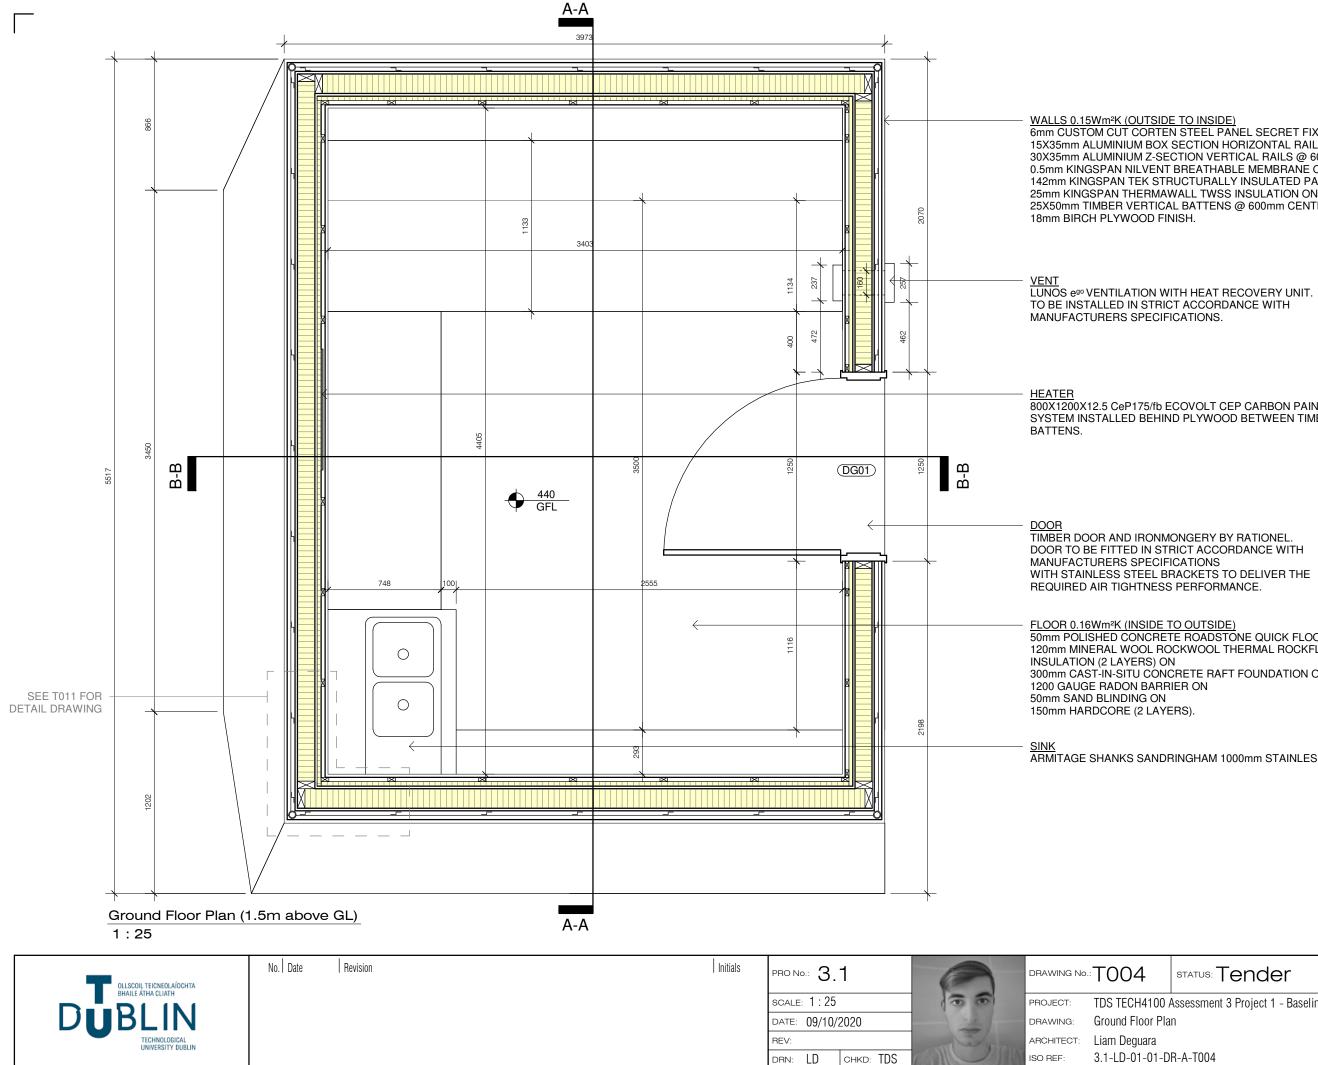



WALLS 0.15Wm²K (OUTSIDE TO INSIDE) 6mm CUSTOM CUT CORTEN STEEL PANEL SECRET FIXED TO 15X35mm ALUMINIUM BOX SECTION HORIZONTAL RAILS @ 600mm CENTRES ON 30X35mm ALUMINIUM Z-SECTION VERTICAL RAILS @ 600mm CENTRES ON 0.5mm KINGSPAN NILVENT BREATHABLE MEMBRANE ON 142mm KINGSPAN TEK STRUCTURALLY INSULATED PANEL ON 25mm KINGSPAN THERMAWALL TWSS INSULATION ON 25X50mm TIMBER VERTICAL BATTENS @ 600mm CENTRES ON


800X1200X12.5 CeP175/fb ECOVOLT CEP CARBON PAINT HEATING SYSTEM INSTALLED BEHIND PLYWOOD BETWEEN TIMBER

DOOR TO BE FITTED IN STRICT ACCORDANCE WITH MANUFACTURERS SPECIFICATIONS WITH STAINLESS STEEL BRACKETS TO DELIVER THE

FLOOR 0.16Wm²K (INSIDE TO OUTSIDE) 50mm POLISHED CONCRETE ROADSTONE QUICK FLOOR SCREED ON 120mm MINERAL WOOL ROCKWOOL THERMAL ROCKFLOOR® 300mm CAST-IN-SITU CONCRETE RAFT FOUNDATION ON 1200 GAUGE RADON BARRIER ON

ARMITAGE SHANKS SANDRINGHAM 1000mm STAINLESS STEEL KITCHEN SINK

STATUS: Tender

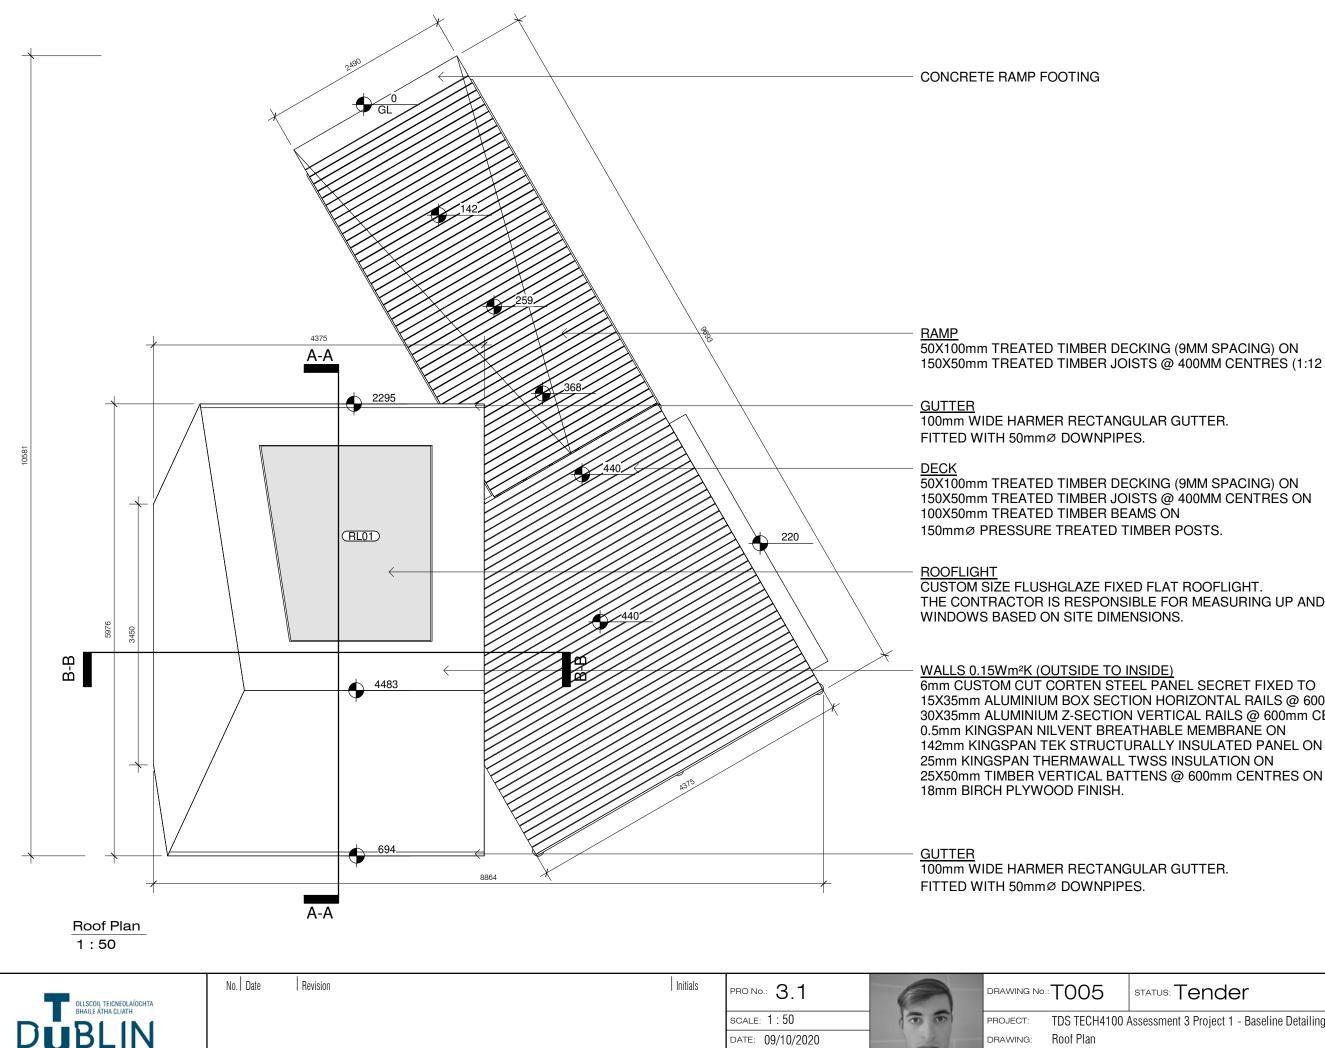

DATE: 09/10/2020

DRN: LD CHKD: TDS

REV:

150X50mm TREATED TIMBER JOISTS @ 400MM CENTRES (1:12 SLOPE).

THE CONTRACTOR IS RESPONSIBLE FOR MEASURING UP AND ORDERING

15X35mm ALUMINIUM BOX SECTION HORIZONTAL RAILS @ 600mm CENTRES ON 30X35mm ALUMINIUM Z-SECTION VERTICAL RAILS @ 600mm CENTRES ON 25X50mm TIMBER VERTICAL BATTENS @ 600mm CENTRES ON

STATUS: Tender

TDS TECH4100 Assessment 3 Project 1 - Baseline Detailing Project


Roof Plan

Liam Deguara

DRAWING:

SO REF:

ARCHITECT:

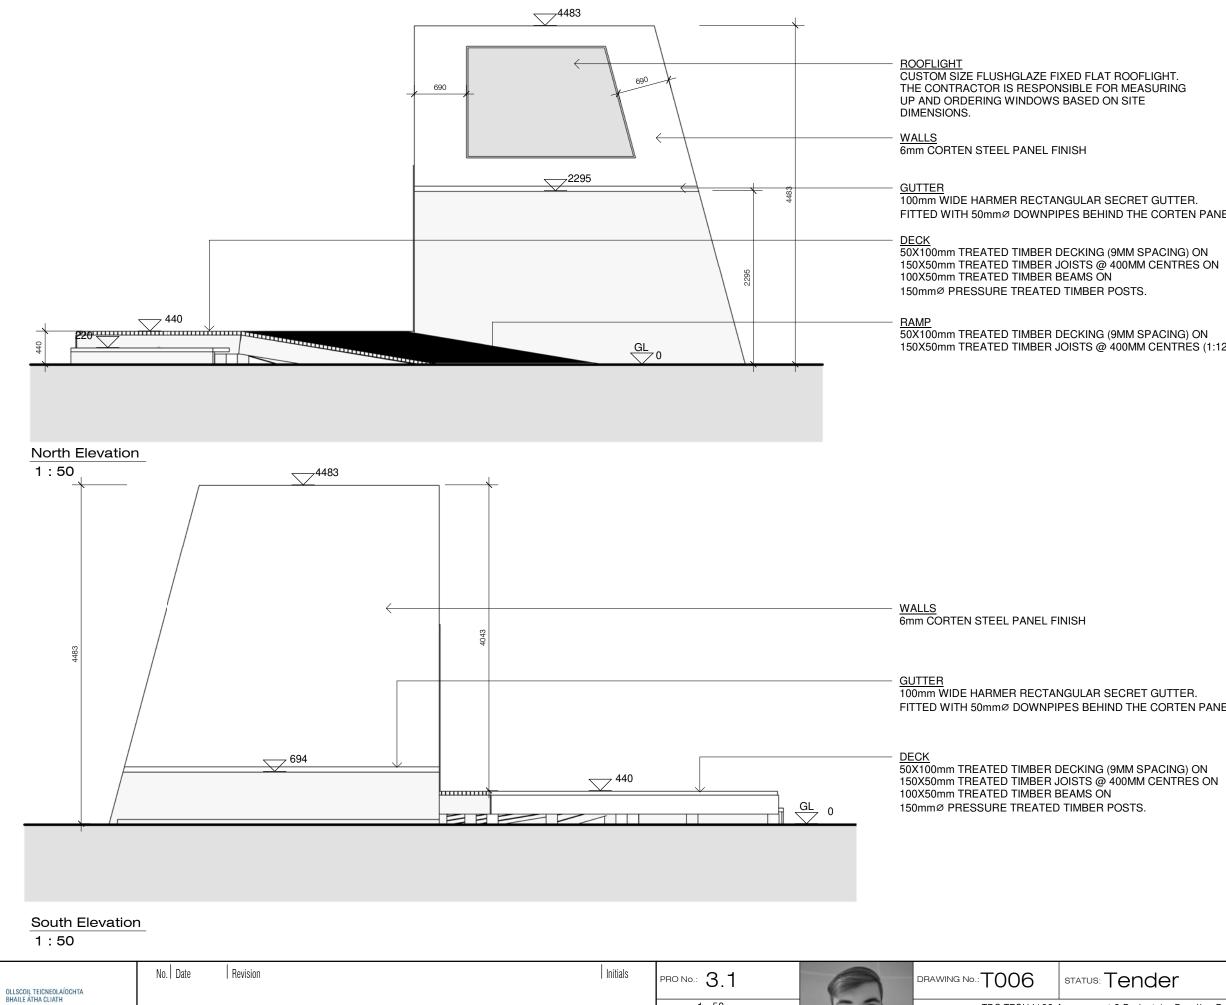

OLLSCOIL TEICNEOLAÍOCHTA BHAILE ÁTHA CLIATH (0) SCALE: 1:50 PROJECT: B DATE: 09/10/2020 DRAWING: REV: ARCHITECT: Liam Deguara UNIVERSITY DUBLI DRN: LD CHKD: TDS ISO REF:

FITTED WITH 50mmØ DOWNPIPES BEHIND THE CORTEN PANEL.

150X50mm TREATED TIMBER JOISTS @ 400MM CENTRES (1:12 SLOPE).


FITTED WITH 50mmØ DOWNPIPES BEHIND THE CORTEN PANEL.

STATUS: Tender

TDS TECH4100 Assessment 3 Project 1 - Baseline Detailing Project

3.1-LD-01-XX-DR-A-T006

Elevations

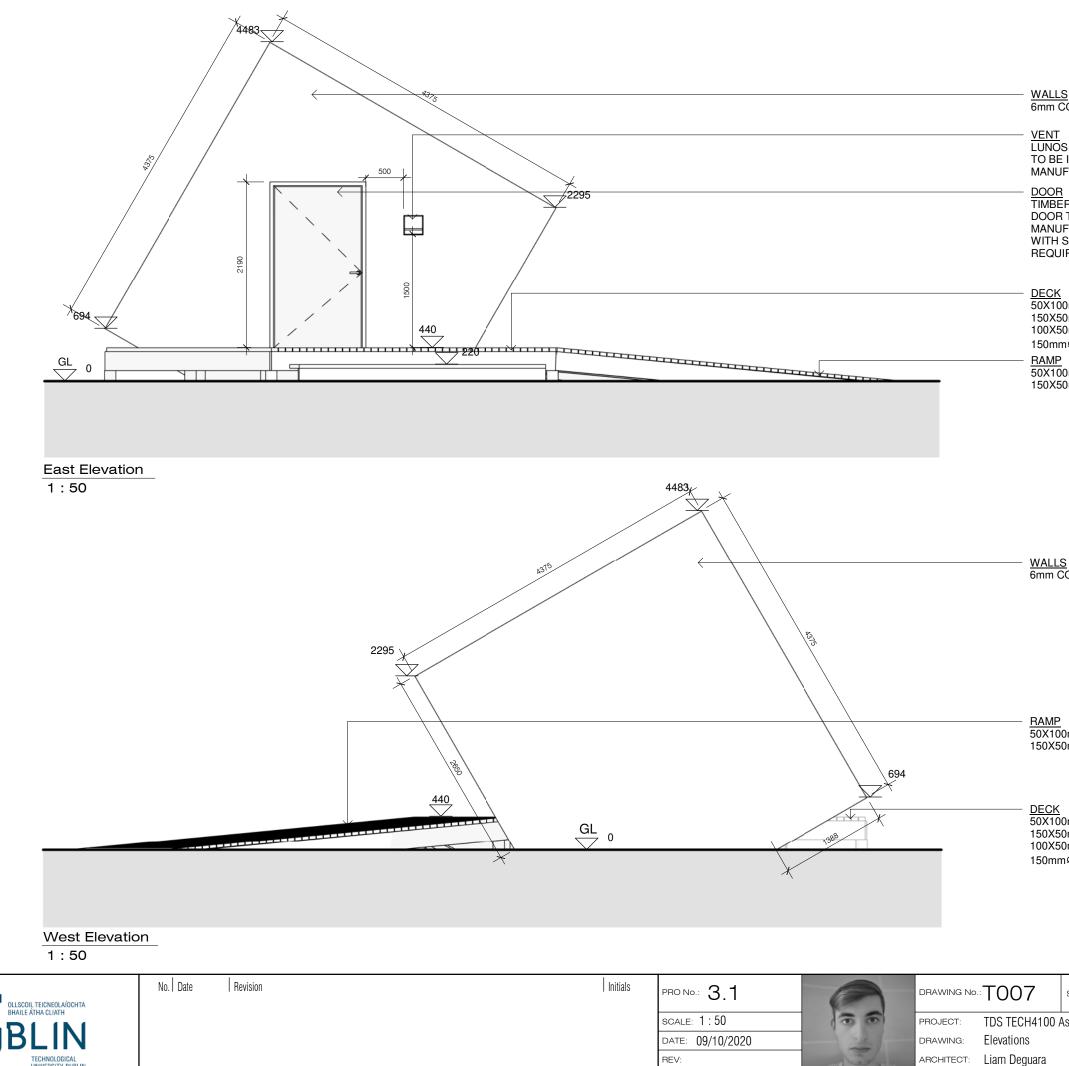

DRN: Author CHKD: Checker

UNIVERSITY DUBLI

6mm CORTEN STEEL PANEL FINISH

VENT LUNOS 6⁹⁰ VENTILATION WITH HEAT RECOVERY UNIT. TO BE INSTALLED IN STRICT ACCORDANCE WITH MANUFACTURERS SPECIFICATIONS.

TIMBER DOOR AND IRONMONGERY BY RATIONEL. DOOR TO BE FITTED IN STRICT ACCORDANCE WITH MANUFACTURERS SPECIFICATIONS WITH STAINLESS STEEL BRACKETS TO DELIVER THE REQUIRED AIR TIGHTNESS PERFORMANCE.

50X100mm TREATED TIMBER DECKING (9MM SPACING) ON 150X50mm TREATED TIMBER JOISTS @ 400MM CENTRES ON 100X50mm TREATED TIMBER BEAMS ON 150mmØ PRESSURE TREATED TIMBER POSTS. 50X100mm TREATED TIMBER DECKING (9MM SPACING) ON 150X50mm TREATED TIMBER JOISTS @ 400MM CENTRES (1:12 SLOPE).

WALLS 6mm CORTEN STEEL PANEL FINISH

50X100mm TREATED TIMBER DECKING (9MM SPACING) ON 150X50mm TREATED TIMBER JOISTS @ 400MM CENTRES (1:12 SLOPE).


DECK 50X100mm TREATED TIMBER DECKING (9MM SPACING) ON 150X50mm TREATED TIMBER JOISTS @ 400MM CENTRES ON 100X50mm TREATED TIMBER BEAMS ON 150mmØ PRESSURE TREATED TIMBER POSTS.

STATUS: Tender


TDS TECH4100 Assessment 3 Project 1 - Baseline Detailing Project

3.1-LD-01-XX-DR-A-T007

ISO REF:

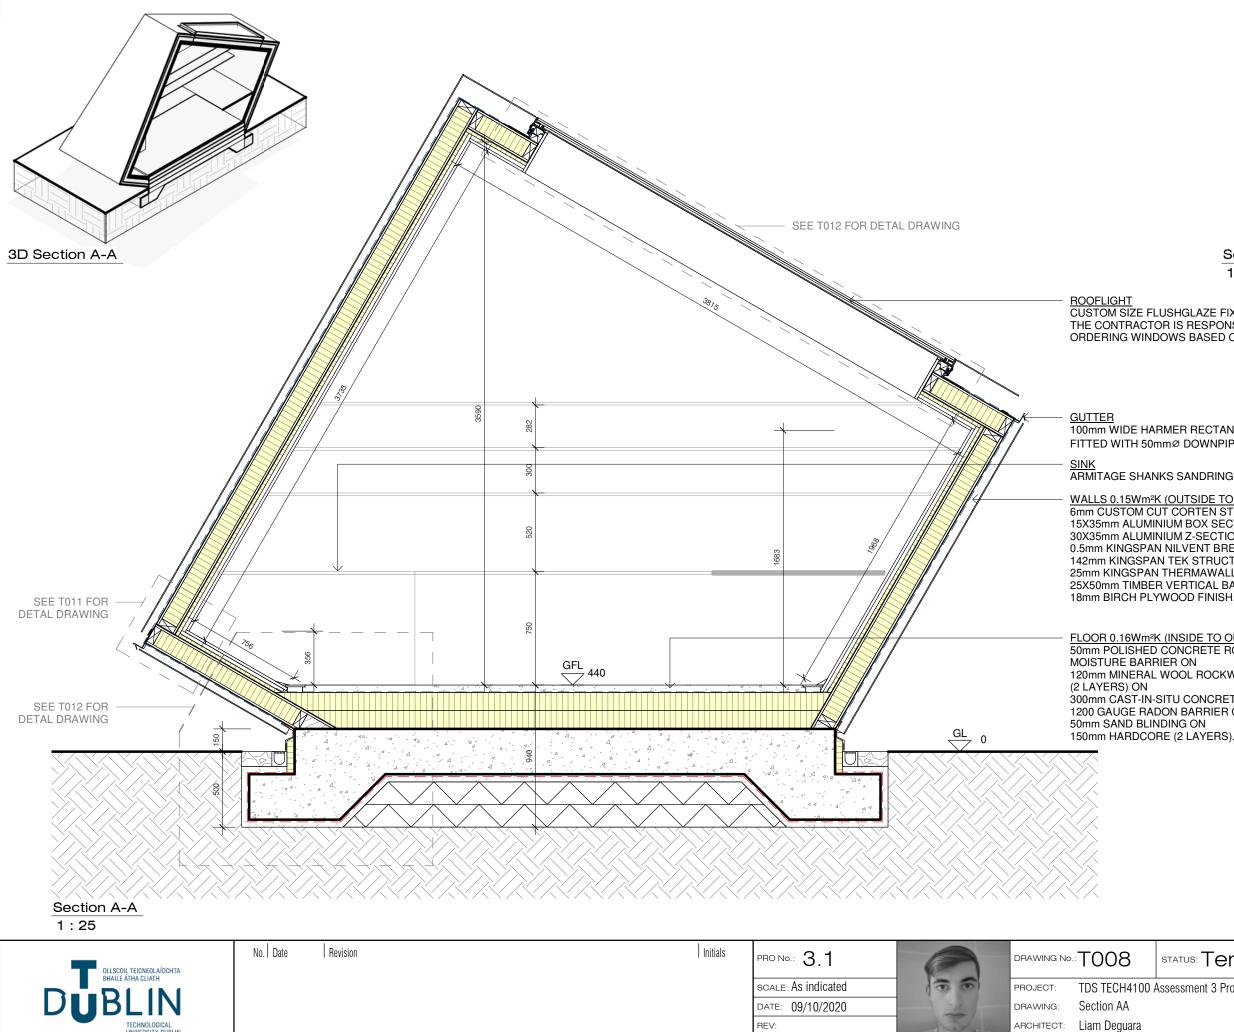

DRN: LD CHKD: TDS

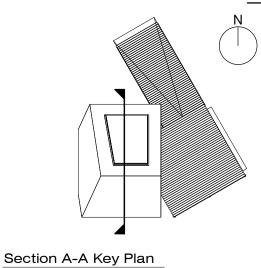

1:200

ROOFLIGHT CUSTOM SIZE FLUSHGLAZE FIXED FLAT ROOFLIGHT. THE CONTRACTOR IS RESPONSIBLE FOR MEASURING UP AND ORDERING WINDOWS BASED ON SITE DIMENSIONS.

100mm WIDE HARMER RECTANGULAR GUTTER. FITTED WITH 50mmø DOWNPIPES.

SINK ARMITAGE SHANKS SANDRINGHAM 1000mm STAINLESS STEEL KITCHEN SINK


WALLS 0.15Wm²K (OUTSIDE TO INSIDE) 6mm CUSTOM CUT CORTEN STEEL PANEL SECRET FIXED TO 15X35mm ALUMINIUM BOX SECTION HORIZONTAL RAILS @ 600mm CENTRES ON 30X35mm ALUMINIUM Z-SECTION VERTICAL RAILS @ 600mm CENTRES ON 0.5mm KINGSPAN NILVENT BREATHABLE MEMBRANE ON 142mm KINGSPAN TEK STRUCTURALLY INSULATED PANEL ON 25mm KINGSPAN THERMAWALL TWSS INSULATION ON 25X50mm TIMBER VERTICAL BATTENS @ 600mm CENTRES ON 18mm BIRCH PLYWOOD FINISH.

FLOOR 0.16Wm²K (INSIDE TO OUTSIDE) 50mm POLISHED CONCRETE ROADSTONE QUICK FLOOR SCREED ON 120mm MINERAL WOOL ROCKWOOL THERMAL ROCKFLOOR® INSULATION 300mm CAST-IN-SITU CONCRETE RAFT FOUNDATION ON 1200 GAUGE RADON BARRIER ON 50mm SAND BLINDING ON


STATUS: Tender

TDS TECH4100 Assessment 3 Project 1 - Baseline Detailing Project

ISO REF:

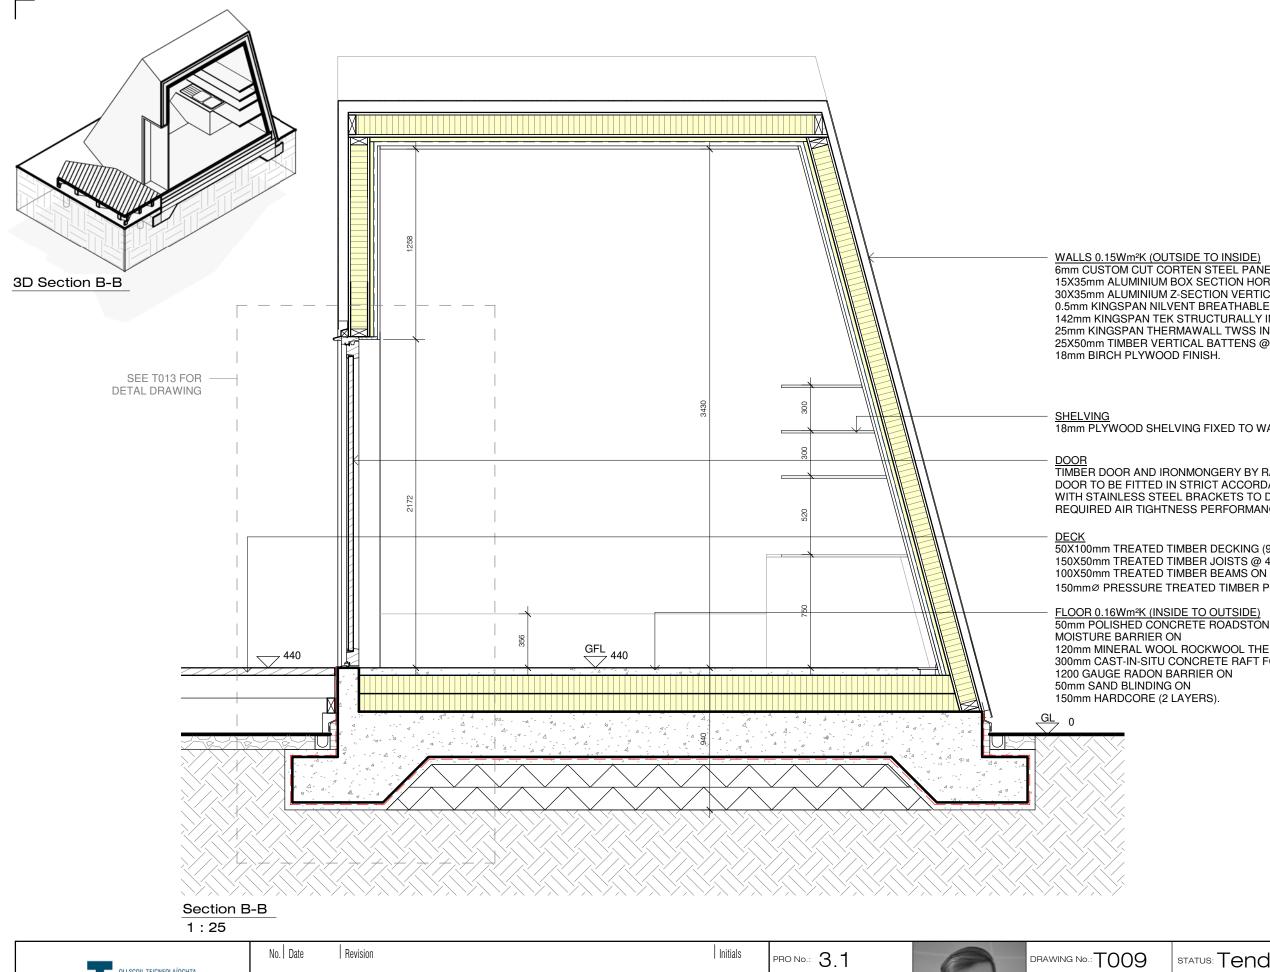

OLLSCOIL TEICNEOLAÍOCHTA	No. Date Revision	Initials	PRO No.: 3.1	0	DRAWING No	T009
BHAILE ÁTHA CLIATH			SCALE: As indicated	(0)	PROJECT:	TDS TECH410
DUBLIN			DATE: 09/10/2020		DRAWING:	Section BB
TECHNOLOGICAL UNIVERSITY DUBLIN			REV:	The Tam	ARCHITECT:	Liam Deguara
			DRN: LD CHKD: TDS		ISO REF:	3.1-LD-XX-01

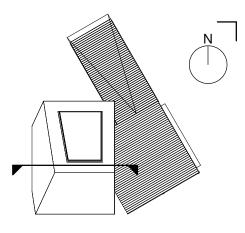

Section B-B Key Plan

1:200

WALLS 0.15Wm²K (OUTSIDE TO INSIDE) 6mm CUSTOM CUT CORTEN STEEL PANEL SECRET FIXED TO 15X35mm ALUMINIUM BOX SECTION HORIZONTAL RAILS @ 600mm CENTRES ON 30X35mm ALUMINIUM Z-SECTION VERTICAL RAILS @ 600mm CENTRES ON 0.5mm KINGSPAN NILVENT BREATHABLE MEMBRANE ON 142mm KINGSPAN TEK STRUCTURALLY INSULATED PANEL ON 25mm KINGSPAN THERMAWALL TWSS INSULATION ON 25X50mm TIMBER VERTICAL BATTENS @ 600mm CENTRES ON

SHELVING 18mm PLYWOOD SHELVING FIXED TO WALL WITH S.S ANGLE BRACKETS.


TIMBER DOOR AND IRONMONGERY BY RATIONEL. DOOR TO BE FITTED IN STRICT ACCORDANCE WITH MANUFACTURERS SPECIFICATIONS WITH STAINLESS STEEL BRACKETS TO DELIVER THE REQUIRED AIR TIGHTNESS PERFORMANCE.

DECK 50X100mm TREATED TIMBER DECKING (9MM SPACING) ON 150X50mm TREATED TIMBER JOISTS @ 400MM CENTRES ON 150mmØ PRESSURE TREATED TIMBER POSTS. 50mm POLISHED CONCRETE ROADSTONE QUICK FLOOR SCREED ON


120mm MINERAL WOOL ROCKWOOL THERMAL ROCKFLOOR® INSULATION (2 LAYERS) ON 300mm CAST-IN-SITU CONCRETE RAFT FOUNDATION ON

STATUS: Tender

00 Assessment 3 Project 1 - Baseline Detailing Project

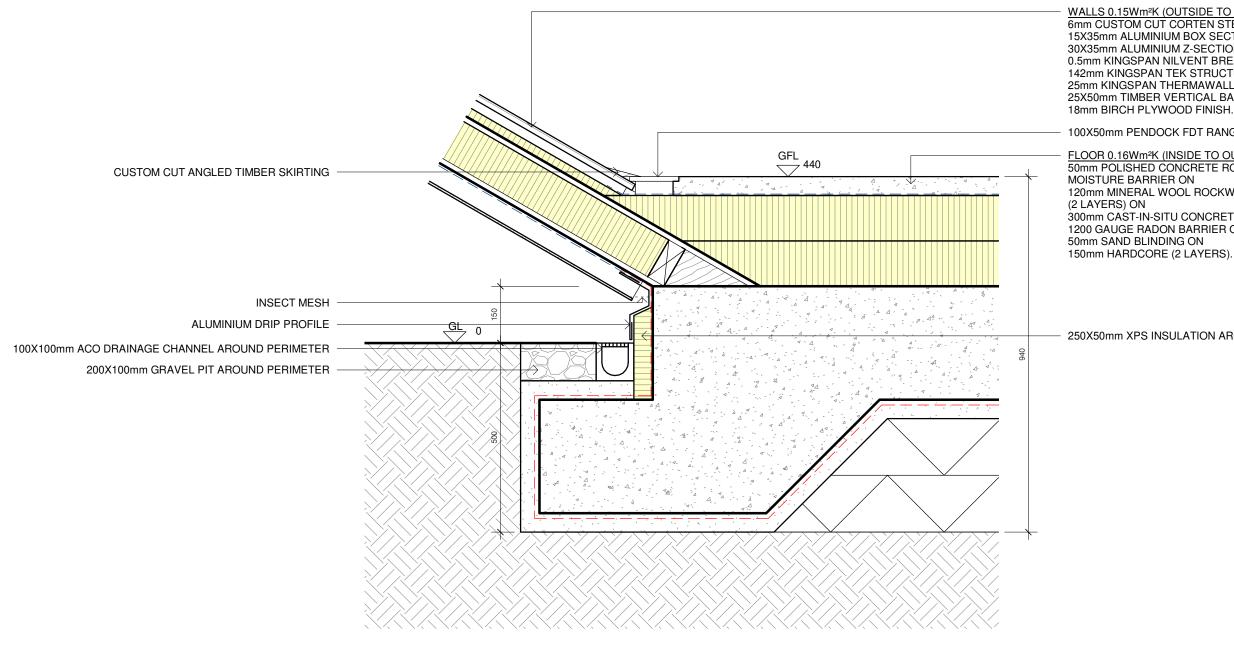

Wall - Floor Detail	
1:10	

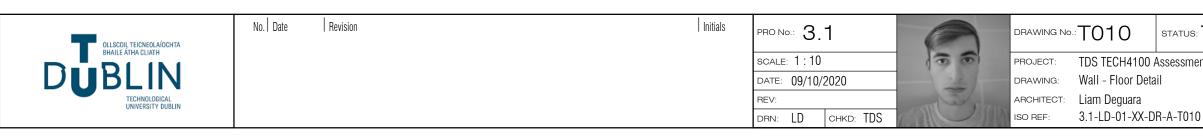

WALLS 0.15Wm²K (OUTSIDE TO INSIDE) 6mm CUSTOM CUT CORTEN STEEL PANEL SECRET FIXED TO 15X35mm ALUMINIUM BOX SECTION HORIZONTAL RAILS @ 600mm CENTRES ON 30X35mm ALUMINIUM Z-SECTION VERTICAL RAILS @ 600mm CENTRES ON 0.5mm KINGSPAN NILVENT BREATHABLE MEMBRANE ON 142mm KINGSPAN TEK STRUCTURALLY INSULATED PANEL ON 25mm KINGSPAN THERMAWALL TWSS INSULATION ON 25X50mm TIMBER VERTICAL BATTENS @ 600mm CENTRES ON


100X50mm PENDOCK FDT RANGE FLUSH FLOOR DUCTING FOR SERVICES

FLOOR 0.16Wm²K (INSIDE TO OUTSIDE) 50mm POLISHED CONCRETE ROADSTONE QUICK FLOOR SCREED ON MOISTURE BARRIER ON 120mm MINERAL WOOL ROCKWOOL THERMAL ROCKFLOOR® INSULATION

300mm CAST-IN-SITU CONCRETE RAFT FOUNDATION ON 1200 GAUGE RADON BARRIER ON 50mm SAND BLINDING ON

250X50mm XPS INSULATION AROUND PERIMETER

STATUS: Tender

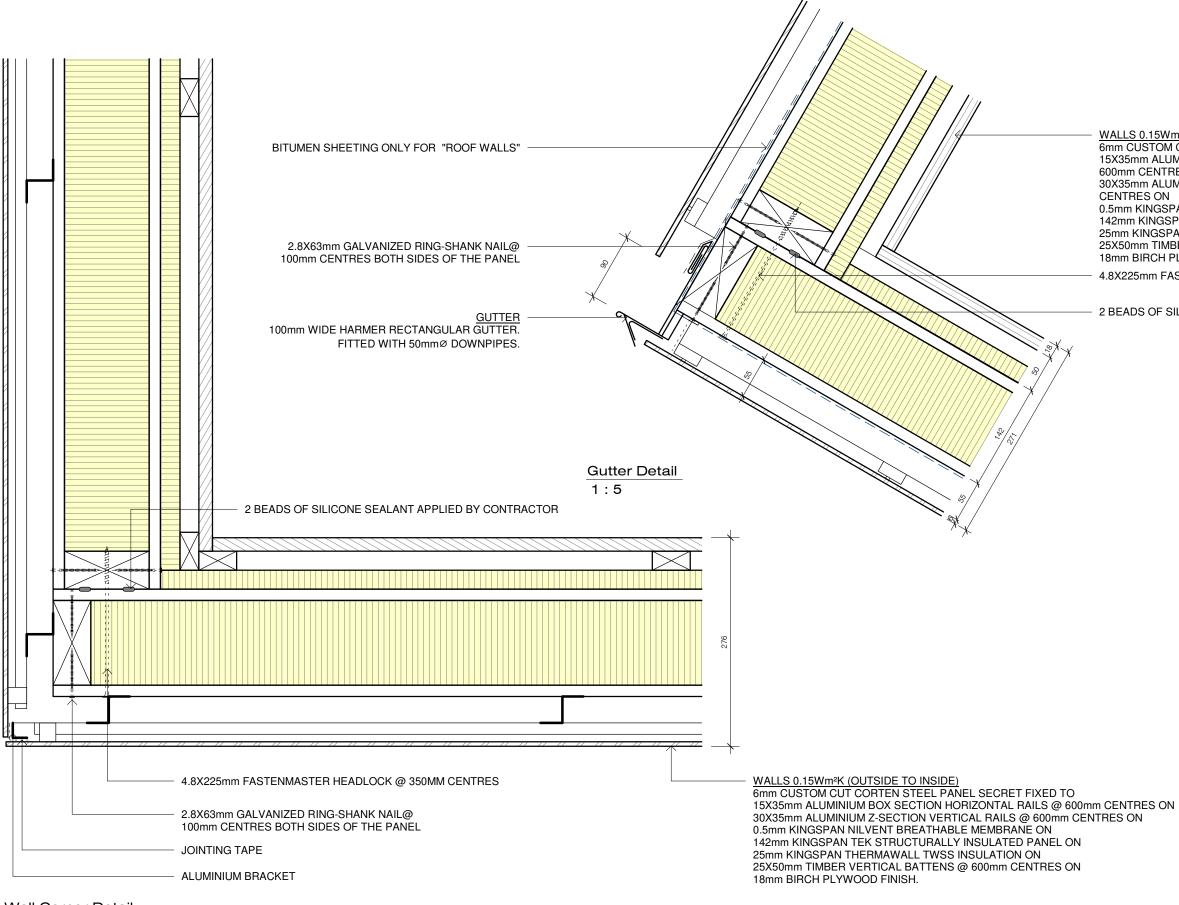

Wall Corner Detail






WALLS 0.15Wm²K (OUTSIDE TO INSIDE) 6mm CUSTOM CUT CORTEN STEEL PANEL SECRET FIXED TO 15X35mm ALUMINIUM BOX SECTION HORIZONTAL RAILS @ 600mm CENTRES ON 30X35mm ALUMINIUM Z-SECTION VERTICAL RAILS @ 600mm CENTRES ON

0.5mm KINGSPAN NILVENT BREATHABLE MEMBRANE ON 142mm KINGSPAN TEK STRUCTURALLY INSULATED PANEL ON 25mm KINGSPAN THERMAWALL TWSS INSULATION ON 25X50mm TIMBER VERTICAL BATTENS @ 600mm CENTRES ON 18mm BIRCH PLYWOOD FINISH.

- 4.8X225mm FASTENMASTER HEADLOCK @ 350MM CENTRES
- 2 BEADS OF SILICONE SEALANT APPLIED BY CONTRACTOR

STATUS: Tender

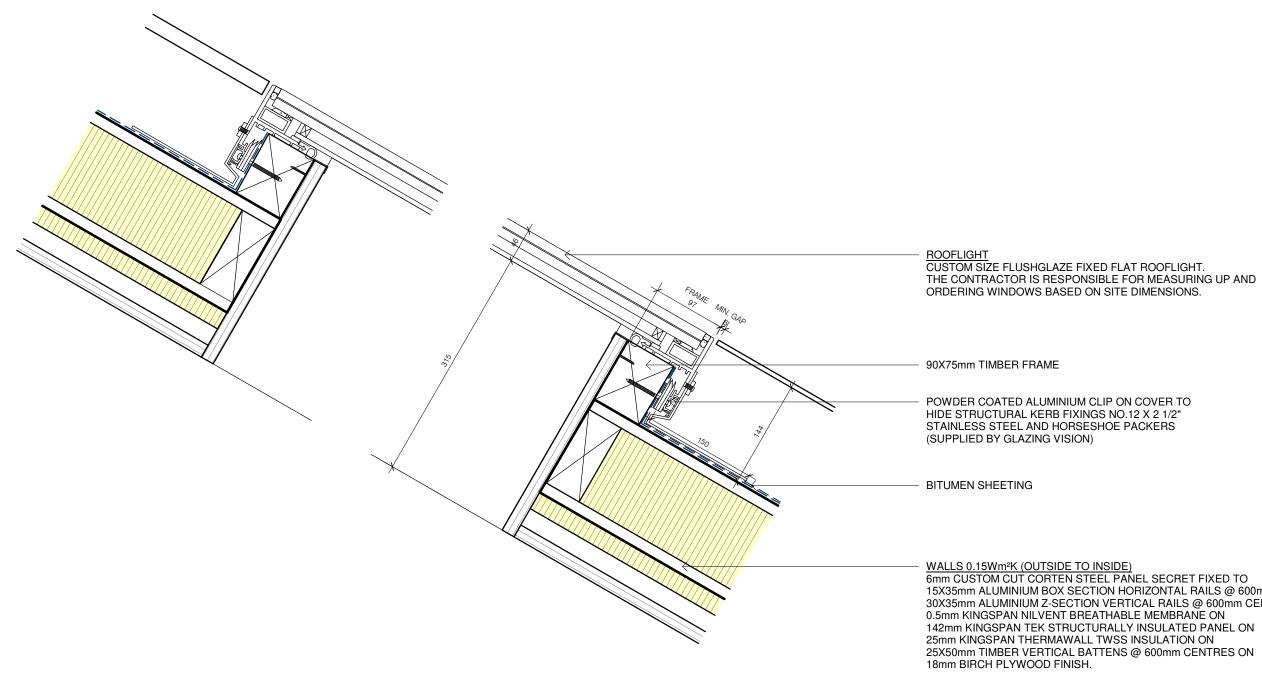

Rooflight Detail 1:5


OLLSCOIL TEICNEOLAÍOCHTA BHAILÉ ÁTHA CLIATH	No. Date Revision	Initials	PRO No.: 3.1	0	DRAWING No	T012
			scale: 1:5	66	PROJECT:	TDS TECH4100
DŪBLIN			DATE: 09/10/2020	14	DRAWING:	Rooflight Detail
TECHNOLOGICAL UNIVERSITY DUBLIN			REV:	The Train	ARCHITECT:	Liam Deguara
			drn: LD chkd: TDS		ISO REF:	3.1-LD-01-XX-

WALLS 0.15Wm²K (OUTSIDE TO INSIDE)
6mm CUSTOM CUT CORTEN STEEL PANEL SECRET FIXED TO
15X35mm ALUMINIUM BOX SECTION HORIZONTAL RAILS @ 600mm CENTRES ON
30X35mm ALUMINIUM Z-SECTION VERTICAL RAILS @ 600mm CENTRES ON
0.5mm KINGSPAN NILVENT BREATHABLE MEMBRANE ON
142mm KINGSPAN TEK STRUCTURALLY INSULATED PANEL ON
25mm KINGSPAN THERMAWALL TWSS INSULATION ON
25X50mm TIMBER VERTICAL BATTENS @ 600mm CENTRES ON
18mm BIRCH PLYWOOD FINISH.

status: Tender

00 Assessment 3 Project 1 - Baseline Detailing Project ail


X-DR-A-T012

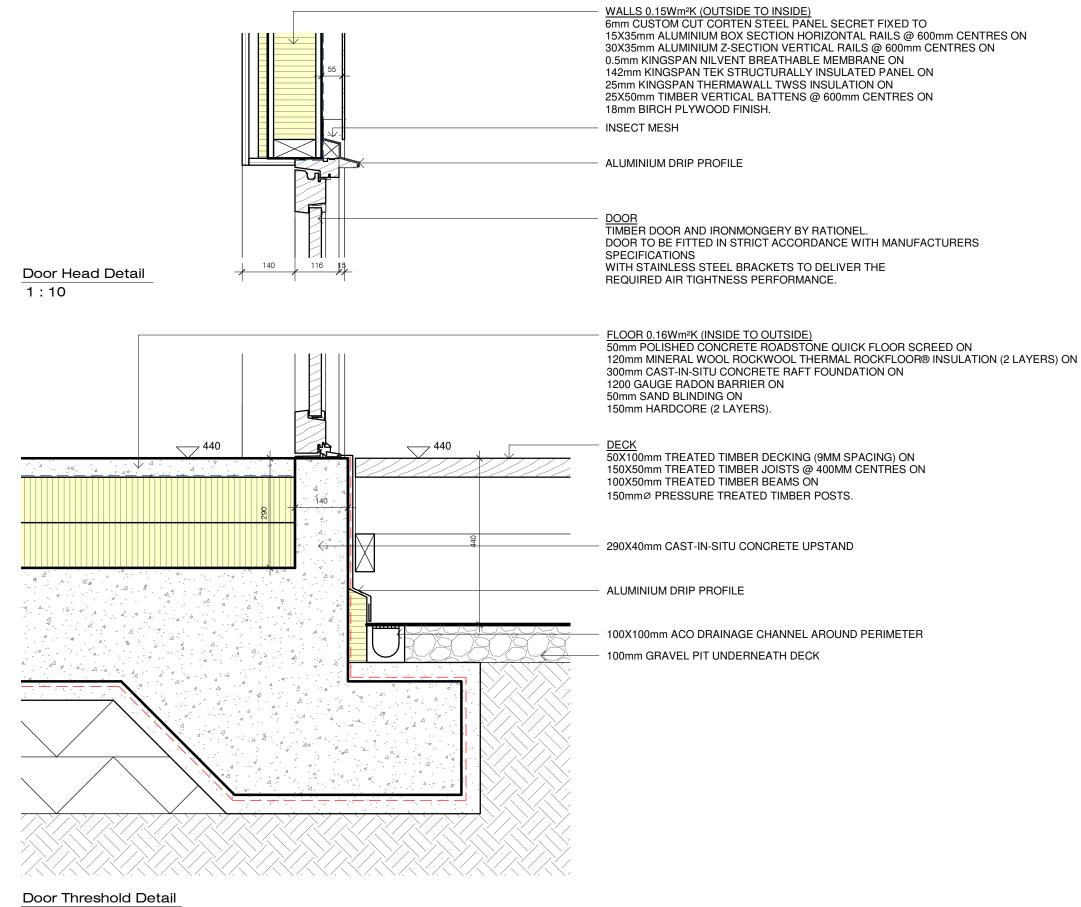





STATUS: Tender

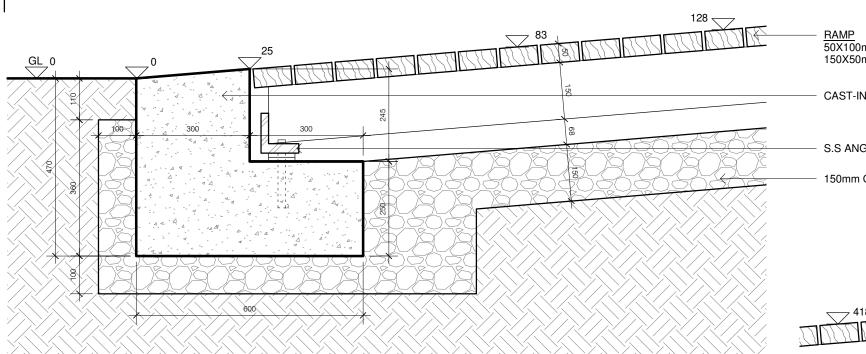



RAMP 50X100mm TREATED TIMBER DECKING (9MM SPACING) ON 150X50mm TREATED TIMBER JOISTS @ 400MM CENTRES (1:12 SLOPE).

CAST-IN-SITU CONCRETE FOOTING (PITCHED TO MEET DECKING)

S.S ANGLE AND ANCHOR BOLT

150mm GRAVEL PIT UNDERNEATH RAMP

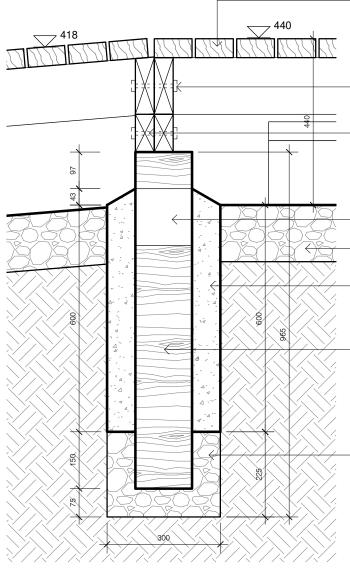

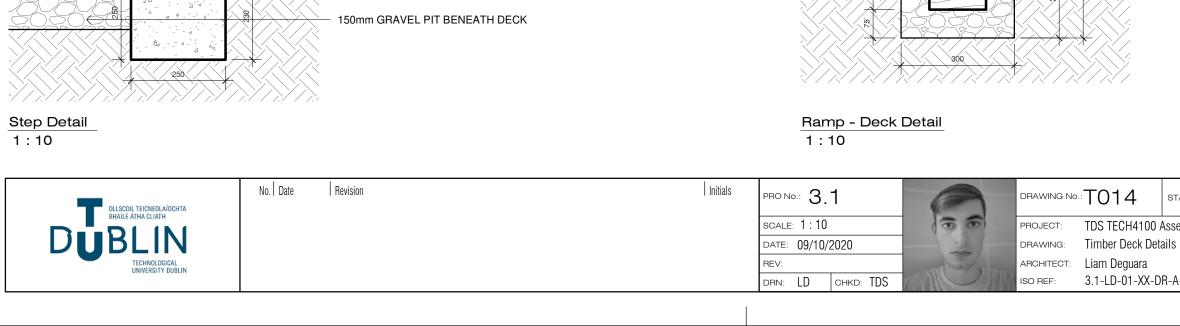

Ramp Base Detail

1:10

GL 0

250

<u>220</u>

DECK 50X100mm TREATED TIMBER DECKING (9MM SPACING) ON 150X50mm TREATED TIMBER JOISTS @ 400MM CENTRES ON 100X50mm TREATED TIMBER BEAMS ON 150mmØ PRESSURE TREATED TIMBER POSTS.

250X50mm TREATED TIMBER STRINGER

250X50mm TREATED TIMBER TREAD BOLTED TO IRON CLEAT WITH 9mmø BOLTS

ANGLE IRON BOLTED TO STRINGER AND TO FOOTING

250X250mm CONCRETE FOOTING

3.1-LD-01-XX-DR-A-T014

STATUS: Tender

TDS TECH4100 Assessment 3 Project 1 - Baseline Detailing Project

GRAVEL FILL

300mmØ CONCRETE PIER

150mmØ TAR PAPER COLLAR


S.S BOLT

150mm GRAVEL PIT BENEATH DECK

150mmØ PRESSURE TREATED TIMBER POST

LEDGER SECURED WITH LAG BOLT

DECK 50X100mm TREATED TIMBER DECKING (9MM SPACING) ON 150X50mm TREATED TIMBER JOISTS @ 400MM CENTRES ON 100X50mm TREATED TIMBER BEAMS ON 150mmØ PRESSURE TREATED TIMBER POSTS.

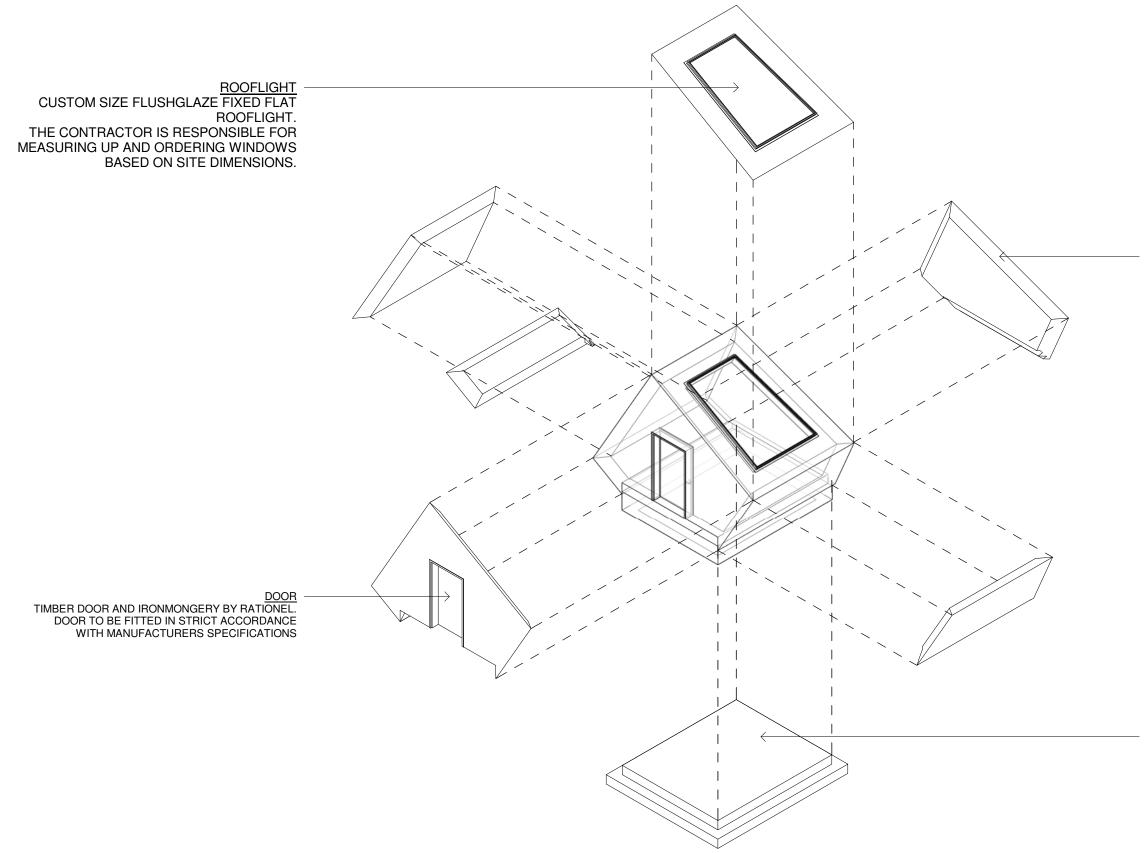

3D Exploded View




WALLS 0.15Wm²K (OUTSIDE TO INSIDE) 6mm CUSTOM CUT CORTEN STEEL PANEL SECRET FIXED TO 15X35mm ALUMINIUM BOX SECTION HORIZONTAL RAILS @ 600mm CENTRES ON 30X35mm ALUMINIUM Z-SECTION VERTICAL RAILS @ 600mm

CENTRES ON 0.5mm KINGSPAN NILVENT BREATHABLE MEMBRANE ON 142mm KINGSPAN TEK STRUCTURALLY INSULATED PANEL ON 25mm KINGSPAN THERMAWALL TWSS INSULATION ON 25X50mm TIMBER VERTICAL BATTENS @ 600mm CENTRES ON 18mm BIRCH PLYWOOD FINISH.


FLOOR 0.16Wm²K (INSIDE TO OUTSIDE) 50mm POLISHED CONCRETE ROADSTONE QUICK FLOOR SCREED ON 120mm MINERAL WOOL ROCKWOOL THERMAL ROCKFLOOR® INSULATION (2 LAYERS) ON 300mm CAST-IN-SITU CONCRETE RAFT FOUNDATION ON 1200 GAUGE RADON BARRIER ON 50mm SAND BLINDING ON 150mm HARDCORE (2 LAYERS).

STATUS: Tender

ROOFLIGHT CUSTOM SIZE FLUSHGLAZE FIXED FLAT ROOFLIGHT. THE CONTRACTOR IS RESPONSIBLE FOR MEASURING UP AND ORDERING WINDOWS BASED ON SITE DIMENSIONS.

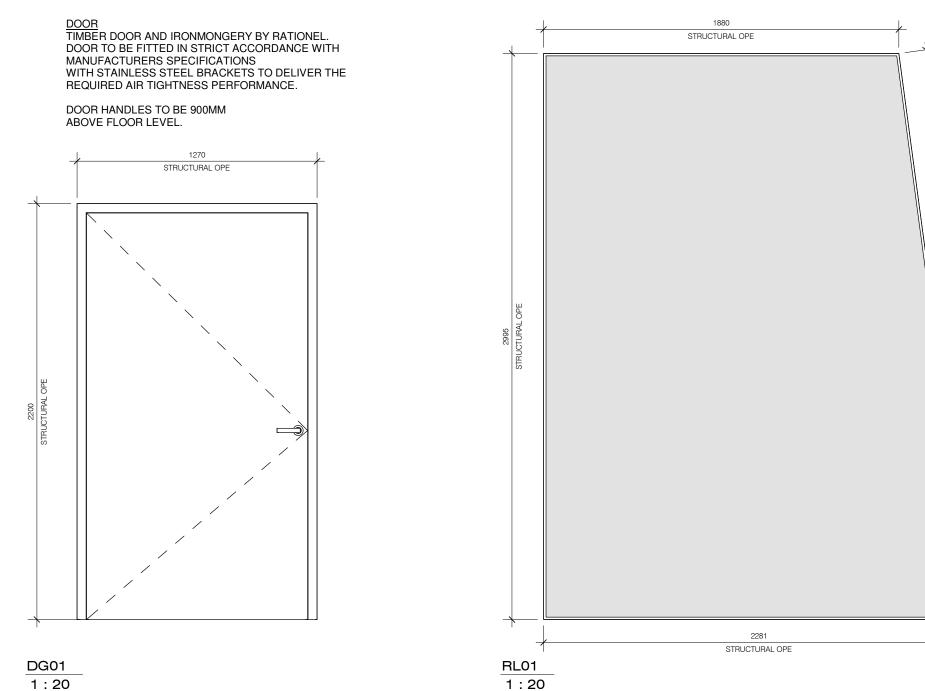



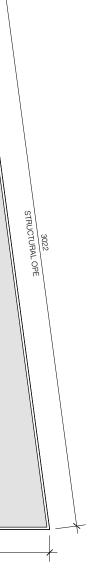

STATUS: Tender

Project Materials Schedule						
Family and Type	Material: Name	Area	Volume	Density (kg/m3)	Item Weight (kg)	
Basic Wall: Wall	Aluminium Chaoting Daila			2710	9841.746605	
	Aluminium - Sheeting Rails Concrete - Pre Cast			2500	5167.012823	
Floor: Floor	Concrete - Sand/Cement Screed	15 m ²	0.73 m ³	2400	1761.845268	
Basic Wall: Wall	Corten Steel	13 11	0.75 m	1000	1507.893681	
Rooflight: Flushglaze Rooflight	Glazing Glass	12 m ²	0.06 m ³	2710	155.968536	
Basic Wall: Wall	Insulation - Rigid insulation			35	51.159833	
Rooflight: Flushglaze Rooflight	Metal - Aluminium	4 m ²	0.04 m ³	900	35.6754	
Sink: Armitage Shanks Sink	Metal Chrome	2 m ²	0.00 m ³	7140	15.51627	
Floor: Floor	Mineral Wool Insulation - Rigid insulation	29 m²	3.52 m ³	70	246.658338	
Floor: Plywood Shelving	Plywood Shelving			680	181.265297	
Basic Wall: Wall	SIP Insulation			35	255.025038	
Basic Wall: Wall	SIP OSB			600	1171.033336	
	Timber Deck Board			500	401.792586	
Basic Wall: Wall	Vertical Timber Battens			500	706.195219	
	Wood - Dimensional Lumber			900	1258.677264	
	Wood - Sheathing - plywood			680	690.947387	
	Wood - Timber			900	175.80528	
Grand total: 187			l.		23624.218161	



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STATUS: Tender